YAVAPAI COUNTY 1015 Fair Street Prescott, Arizona

() REVIEWED FOR CODE COMPLIANCE

PROJECT INFORMATION

ALL WORK SHALL CONFORM TO ALL YAVAPAI COUNTY ADOPTED CODES, ORDINANCES AND POLICIES INCLUDING BUT NOT LIMITED TO THE FOLLOWING 2018 INTERNATIONAL RESIDENTIAL CODE (IRC) 2018 INTERNATIONAL PLUMBING CODE (IPC) 2018 INTERNATIONAL MECHANICAL CODE (IMC 2017 NATIONAL ELECTRIC CODE (NEC) LIVABLE 1,300 SQ. FT.

COVERED ENTRY: 65 SQ. FT. CARPORT 400 SQ. FT. 62 SQ. FT. STORAGE:

TOTAL UNDER ROOF: 1,827 SQ. FT. OCCUPANCY: R-3 (Single-Family Residential)

CONSTRUCTION TYPE: V-B

INDEX TO DRAWINGS

PROJECT INFO / FLOOR PLAN / OPENING SCHEDULES

GARAGE ALTERNATE SHEET

FOUNDATION PLAN / DETAILS

EXTERIOR ELEVATIONS / BLDG. SECTION A-4.0

ROOF FRAMING PLAN / DETAILS

HVAC / ELECTRICAL PLANS

GENERAL NOTES

A - 3.0

I. DUE TO REPROGRAPHIC PROCESS, THESE PLANS MAY NOT BE ACCURATE TO SCALE, DIMENSIONS ARE NOT TO BE SCALED FROM THE WORKING DRAWINGS.

2. BEFORE ORDERING ANY MATERIALS OR STARTING ANY WORK, CONTRACTORS SHALL VERIFY ALL MEASUREMENTS AND EXISTING CONDITIONS AT THE SITE AND SHALL BE RESPONSIBLE FOR THE CORRECTNESS OF THE SAME. ANY DEVIATION AND/OR UNSAFE OR UNREGULATED CONDITIONS SHALL BE BROUGHT TO THE ATTENTION OF YAVAPAI COUNTY DEVELOPMENT SERVICES.

3. GENERAL CONTRACTOR TO VERIFY AND LOCATE ALL UTILITY STUB OUTS AND MAINS BEFORE BEGINNING CONSTRUCTION OF PROJECT.

4. GENERAL CONTRACTOR TO VERIFY THE REMOVAL AND/OR REPLANTING OF LANDSCAPE IF THE CONDITION OCCURS OVER THE PROJECT SITE. 5. DAMAGE TO SITE, UTILITIES, OR NEWLY BUILT IMPROVEMENTS, NOT DESIGNED FOR REMOVAL, SHALL BE THE RESPONSIBLITY OF THE GENERAL CONTRACTOR INVOLVED, AND SHALL BE REPAIRED OR REPLACED AT THE

6. VERIFY UNIFORMITY OF ALL FRAMING SO AS TO CREATE A SMOOTH, REGULAR FINISH WITH NO IRREGULARITIES.

7. IT IS THE RESPONSIBILITY OF THE GENRAL CONTRACTOR, TO THOROUGHLY REVIEW THE PLANS AND TO NOTIFY YAVAPAI COUNTY DEVELOPMENT SERVICES OF ANY DISCREPANCIES. YAVAPAI COUNTY, NOR THE ARCHITECT-OF-RECORD, WILL NOT BE RESPONSIBLE FOR MATERIALS IMPROPERLY ORDERED OR INSTALLED.

8. FAILURE BY THE GENERAL CONTRACTOR, OR SUB-CONTRACTORS, TO AQUAINT THEM-SELVES WITH ALL AVAILABLE INFORMATION CONCERNING THIS PROJECT SHALL NOT RELIEVE THEM OF THE RESPONSIBILITY TO PERFORM THEIR

- 9. APPROVAL OF ALL CONSTRUCTION IS SUBJECT TO FIELD VERIFICATION BY YAVAPAI COUNTY PERSONELL.
- 10. EVERY SLEEPING ROOM SHALL HAVE AT LEAST ONE (1) OPERATING WINDOW, OR DOOR, FOR EMERGENCY EGRESS, OPEN DIRECTLY TO A STREET, ALLEY, OR YARD.
- 11. ALL INTERIOR WALL, AND CEILING FINISHES, SHALL BE TAPED, TEXTURED, AND PAINTED 1/2" DRYWALL. PROVIDE "GREENBOARD' BEHIND ALL TUB ENCLOSURES.

EFFECTIVE APRIL 20, 2006 FULLY SHIELDED FIXTURES ARE REQUIRED FOR ALL EXTERIOR LAMP


RAIN GUTTERS / DRAINAGE Rainwater from roofs and storm water from paved areas yards, courts and courtyards shall drain to an approved place of disposal. (1101.2 2018 IPC) Drainage away from structure shall be determined by Geotechnical Report.

EXPENSE OF THE SAME.

SPECIAL INSPECTION Reports to be supplied to **Building Inspector**

CAUTION avapai County permitted building plans do not relieve the Owner or General Contractor from their responsibilities to conform to all adopted building codes. Every effort has been made to provide a thorough plan review, however plans may contain irregularities. he issue has been resolved through Yavapai County and any professional involved in the project.

Yavapai County Ordinance, Section 112.6 Drainage across Property Lines. Orainage across property lines shall not exceed that which existed prior to grading. Excess or concentrated drainage shall be contained on site Erosion of the ground in the area of discharge shall be prevented by installation of non-erosive down-drains or other devices.

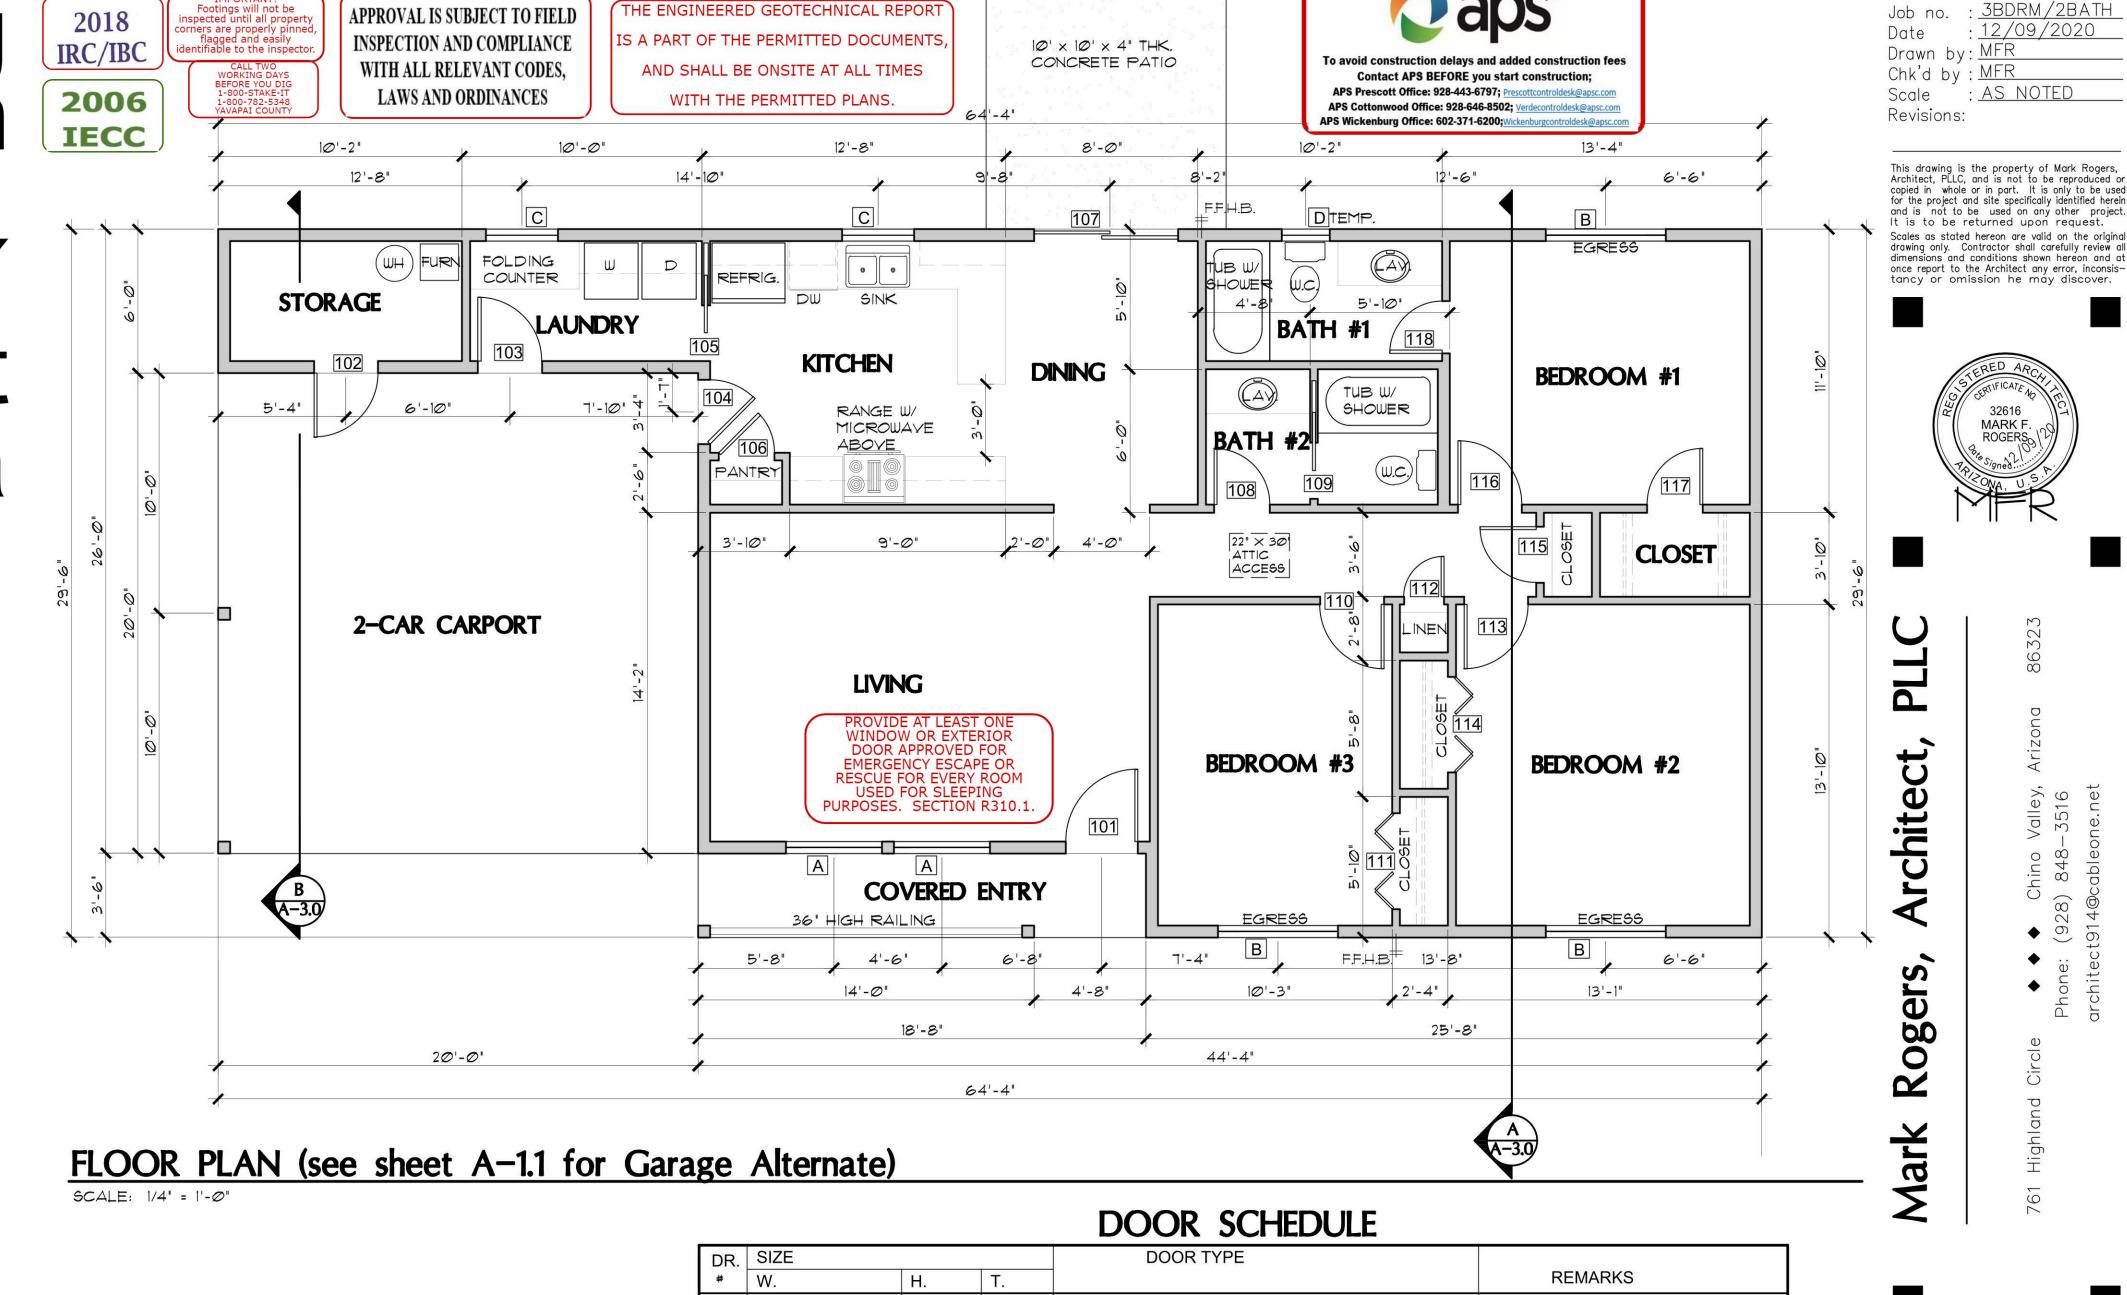

1-3/4"

1-3/4"

1-3/4"

1-3/4"

1-3/8"

1-1/2"

1-1/2"

1-3/8"

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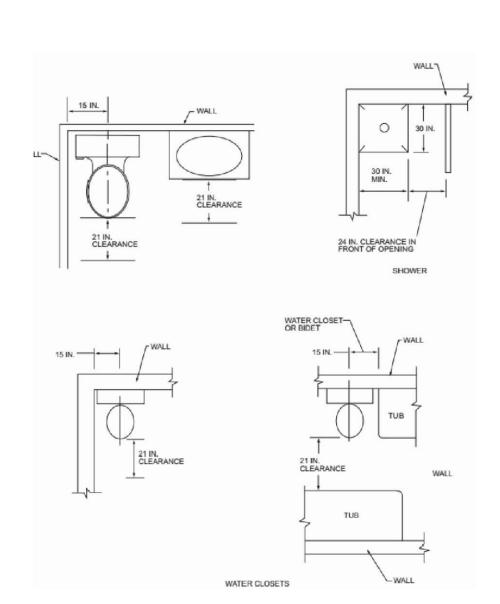
6'-8"

6'-8"


6'-8"

6'-8"

6'-8"





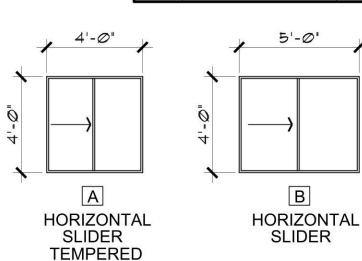

101 | 3'-0"

102 2'-8"

103 | 2'-8"

105 | 2'-4"

106 | 3'-0"

107 | 6'-0"

108 | 5'-0"

109 | 5'-0"

110 | 2'-8"

111 | 4'-0"

112 | 1'-8"

113 | 2'-8"

114 | 4'-0"


115 | 2'-4"


116 | 2'-8"

117 | 2'-4"

118 | 2'-4"

104

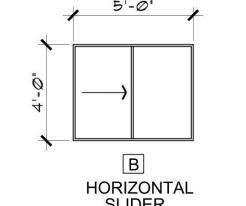

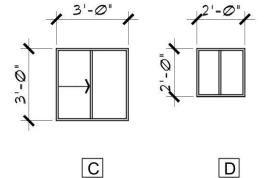

HORIZONTAL **HORIZONTAL TEMPERED GLASS**

NOTE: FENESTRATION IN ZONE 2 (ELEVATIONS BELOW 3500 FT.) SHALL HAVE A MAXIMUM U-FACTOR OF 0.75, AND A MAXIMUM FENESTRATION SHGC FACTOR OF 0.40. FENESTRATION IN ZONE 4 (ELEVATIONS 3500 FT. AND ABOVE) SHALL HAVE A MAXIMU U-FACTOR OF 0.40. THE SHGC FACTOR IN ZONE 4 IS NOT APPLICABLE.

SELF-CLOSING & SELF-LATCHING PROVIDE THRESHOLD AND

WEATHERSTRIPPING

REVIEWED FOR DESIGN CRITERIA ONLY

SHEET NO: A - 1.0

K

>

B

| HOO

1-1/2" INTERIOR 4-PANEL HOLLOW CORE 1-1/2" **INTERIOR 4-PANEL HOLLOW CORE**

EXTERIOR 6-PANEL SOLID-CORE WOOD

EXTERIOR FLUSH SOLID-CORE WOOD

EXTERIOR FLUSH SOLID-CORE WOOD

INTERIOR 4-PANEL SLIDING POCKET DOOR

INTERIOR 4-PANEL SLIDING POCKET DOOR

EXTERIOR SLIDING-GLASS PATIO DOOR

2-PANEL SOLID-CORE WOOD W/

TEMPERED GLASS VISION PANEL

INTERIOR 4-PANEL HOLLOW CORE


INTERIOR 4-PANEL BI-FOLD


INTERIOR 4-PANEL BI-FOLD

WINDOWS SHALL BE VINYL FRAME MAX. U-FACTOR: 0.40 (OPTION TO ELIMINATE FOUNDATION **INSULATION IF USING 0.32 OR BELOW** U-FACTOR)

WINDOW TYPES

GLASS

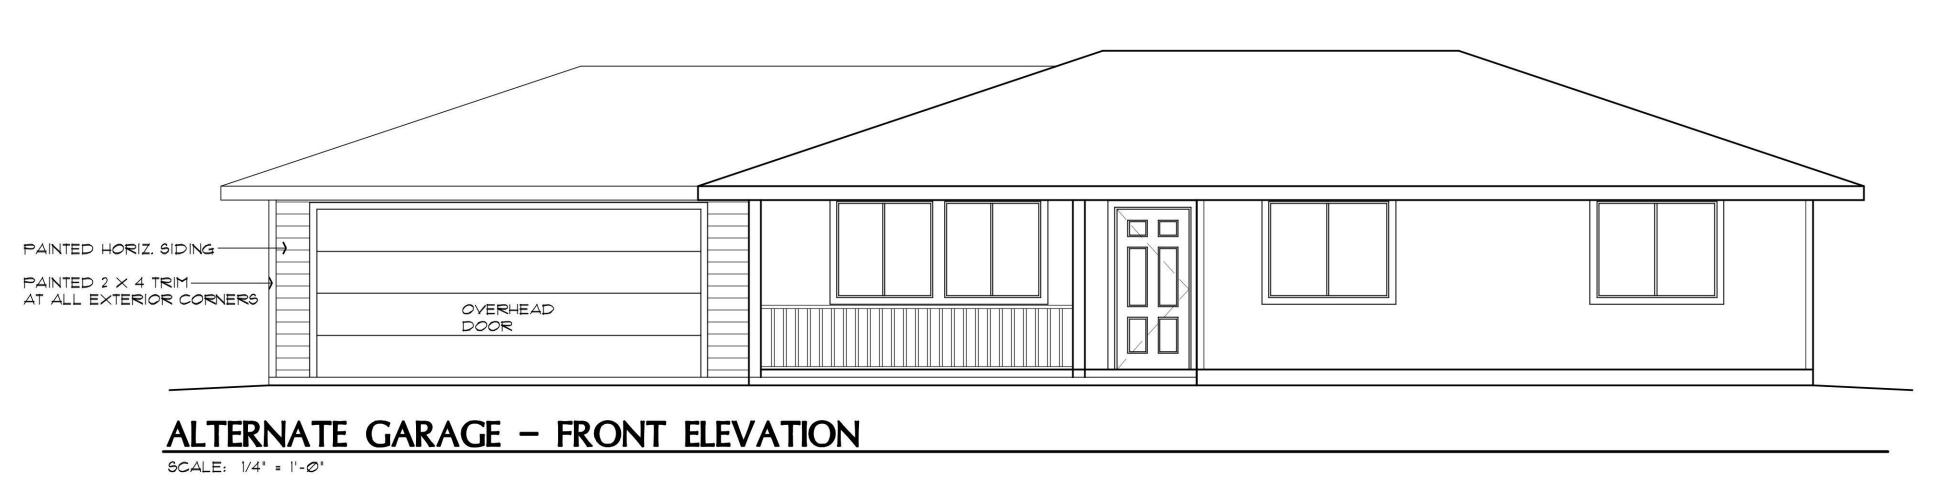

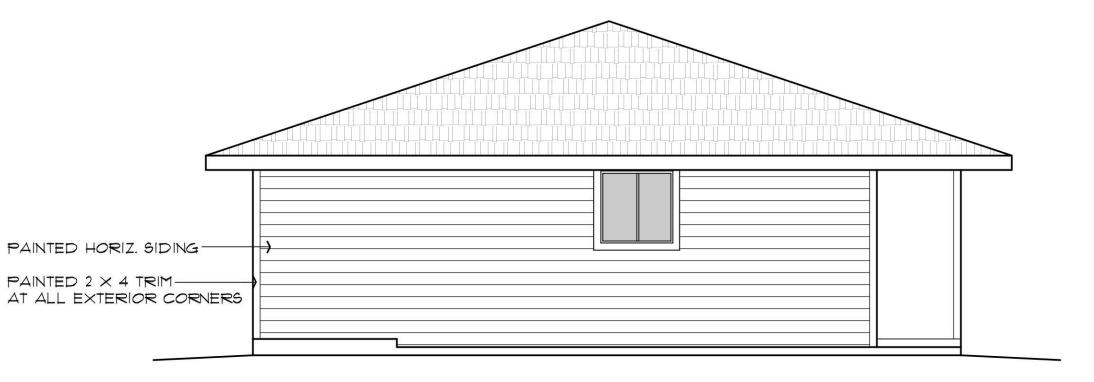

ALTERNATE GARAGE - LEFT SIDE ELEVATION


E.I.F.S. OVER "TYVEK" HOUSE WRAP (OR OTHER EQUAL) ON 1/2" PLYWOOD SHEATHING ON 2 X STUDS AT 16" O.C. CONT. MTL. WEEP SCREED 2" MIN. AT CONCRETE 4" MIN. AT FINISH GRADE - APPROX. FINISH GRADE STUCCO BASE DETAIL

NOTE: STUCCO MAY BE USED IN LIEU OF THE HORIZ. SIDING. PROVIDE A WEEP SCREED AT THE BASE OF THE STUCCO AT THE EXTERIOR.

SCALE: 1/4" = 1'-0"

RAIN GUTTERS / DRAINAGE Rainwater from roofs and storm water from paved areas, yards, courts and courtyards shall drain to an approved place of disposal. (1101.2 2018 IPC) Drainage away from structure shall be determined by Geotechnical Report.

APPROVAL IS SUBJECT TO FIELD INSPECTION AND COMPLIANCE WITH ALL RELEVANT CODES, LAWS AND ORDINANCES

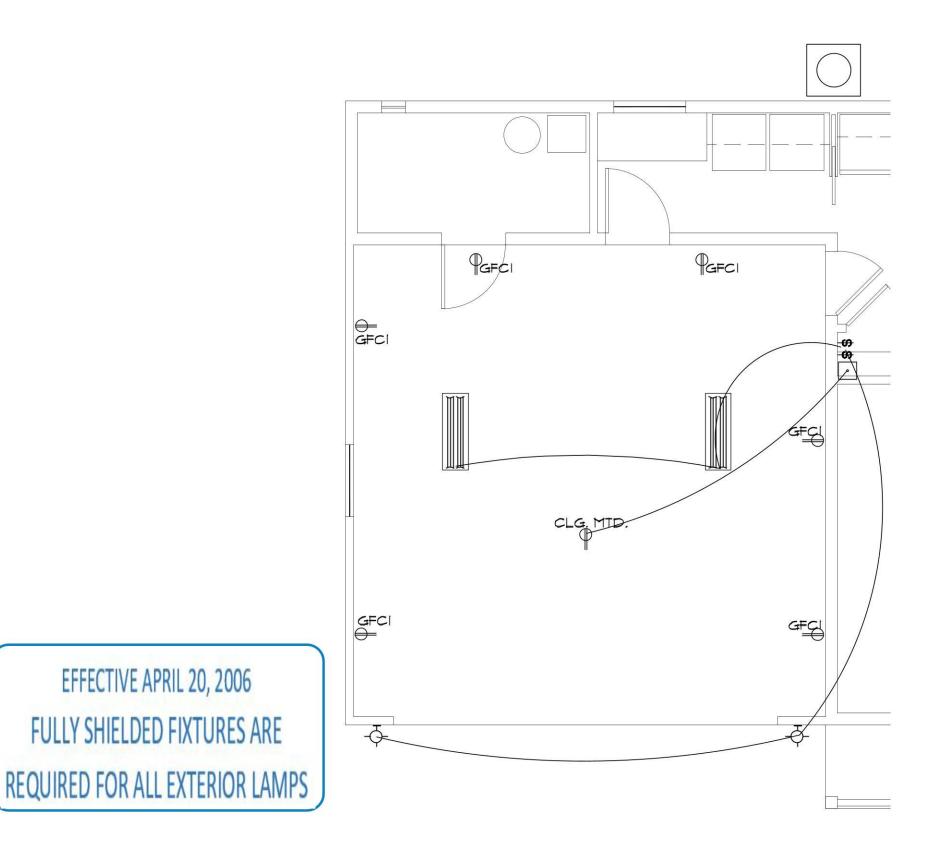


ALTERNATE GARAGE ELECTRICAL PLAN

SCALE: 1/4" = 1'-0"

EFFECTIVE APRIL 20, 2006


FULLY SHIELDED FIXTURES ARE

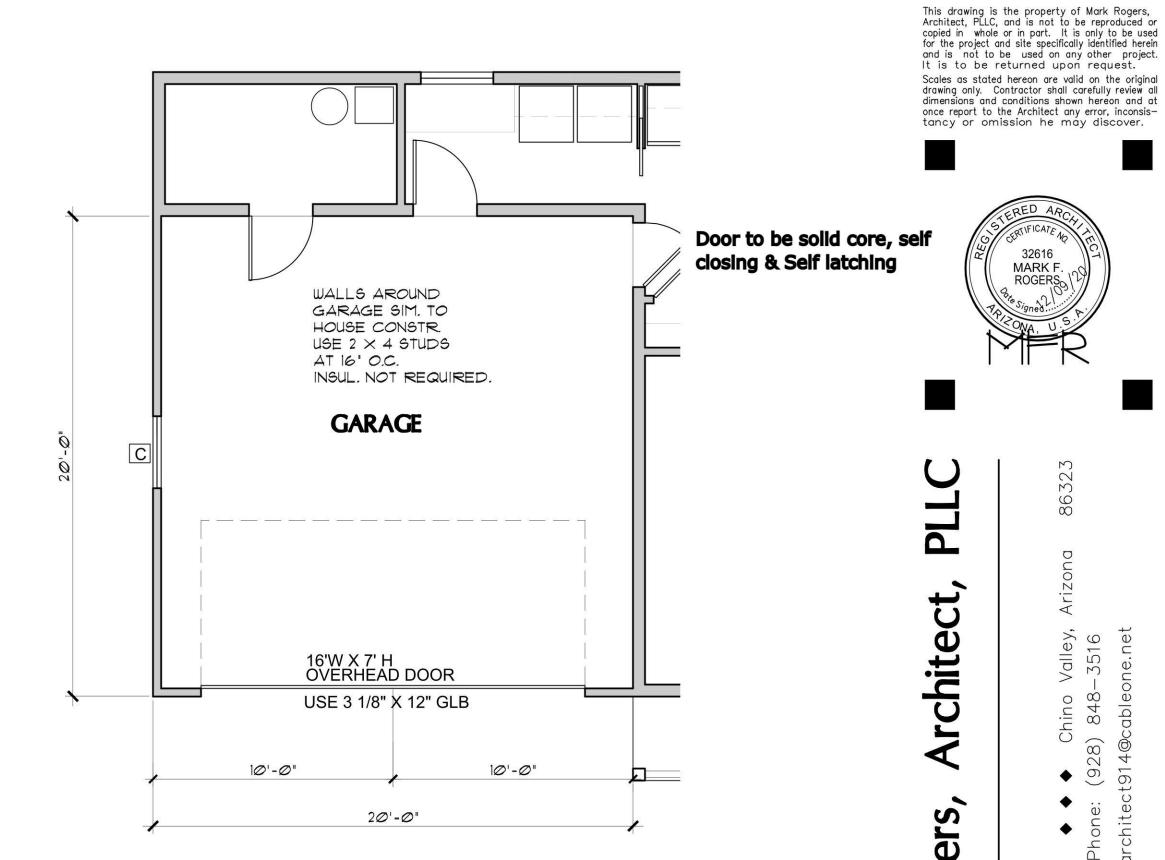

ALTERNATE GARAGE FLOOR PLAN

SCALE: 1/4" = 1'-0"

PER SECTION 110.3.4 OF THE 2018 YCABC ORDINANCE 2014-1: PRE-SLAB INSPECTIONS ARE REQUIRED

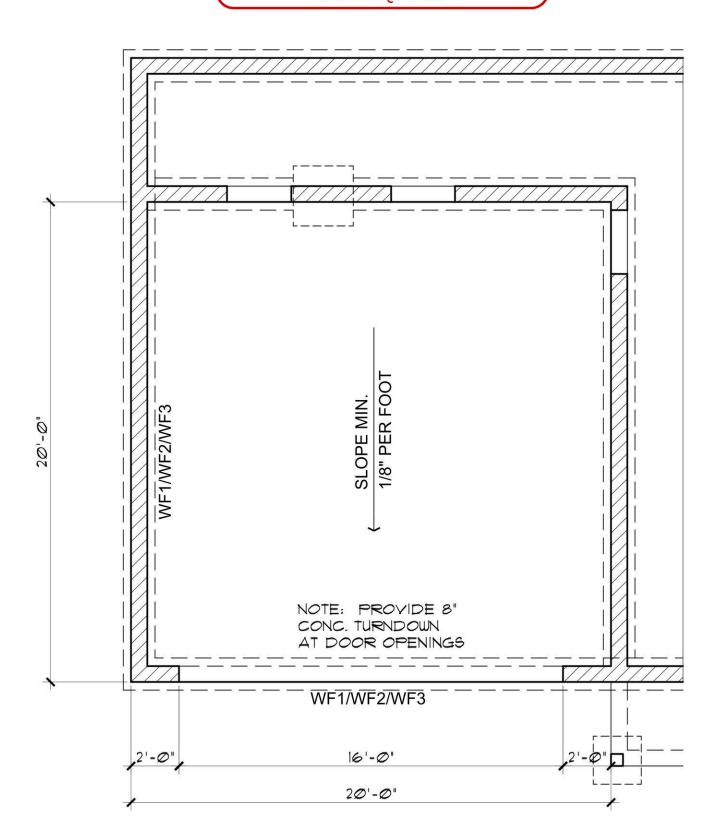

ALTERNATE GARAGE FOUNDATION PLAN

SCALE: 1/4" = 1'-0"

REVIEWED FOR DESIGN CRITERIA ONLY

A - 1.1

Mar

ARIZONA

YAVAPAI

SHEET NO:

ARAGE 2 BATH

ALTERNATE 3 BEDROOM

Drawn by: MFR Chk'd by : MFR

: AS NOTED


32616 MARK F


ROGERS \


Scale

Revisions:

- 2. SIMPSONS H2.5A HANGERS TO BE APPLIED @ ALL TRUSS
- 3. PROVIDE A MINIMUM OF 1 SQ. FT. OF ATTIC VENTILATION FOR EACH 150 SQ. FT. OF ATTIC SPACE.
- 4. ALL PLYWOOD SHEATHING STD. GRADE 5/8" CDX NAIL 8d @ 6" EDGES -12" FIELD STAGGER JOINTS.
- 5. SUPPORTED MEMBERS OF G.L.B. & GIRDERS OR OTHER CONCENTRATED LOADS SUPPORTED BY WALL OR PIER SHALL HAVE BEARING AT LEAST AS WIDE AS THE ROOF
- 6. ROOF PITCH 4:12 (TYP.).
- 7. OVERHANGS TO BE 24".
- 8. FURNACE IN ATTIC: PROVIDE A 24" SOLID PASSAGEWAY TO CONTROL SIDE OF APPLIANCE AND A 30" SERVICE SPACE ON THE CONTROL SIDE OF THE APPLIANCE (REQUIRED FOR ATTIC MOUNT FURNACES)
- 9. ALL OVER FRAMING REQUIRES SLEEPER OR BLOCKING AND COLLAR TIES
- 10. ALL RAFTERS SHALL BE DOUGLAS FIR #2 (SIZE PER PLAN) ALL STUDS SHALL BE HEM FIR #2 (SIZE PER PLAN)
- 11. PROVIDE TEMP. BRACING, SHORING AND GUTTING TO AVOID EXCESSIVE STRESSES AND TO HOLD STRUCTURAL ELEMENT IN PLACE DURING ERECTION.
- 12. PROVIDE MFR'S, DRAWINGS AND ENGINEERING FOR ALL PRE-FAB TRUSSES

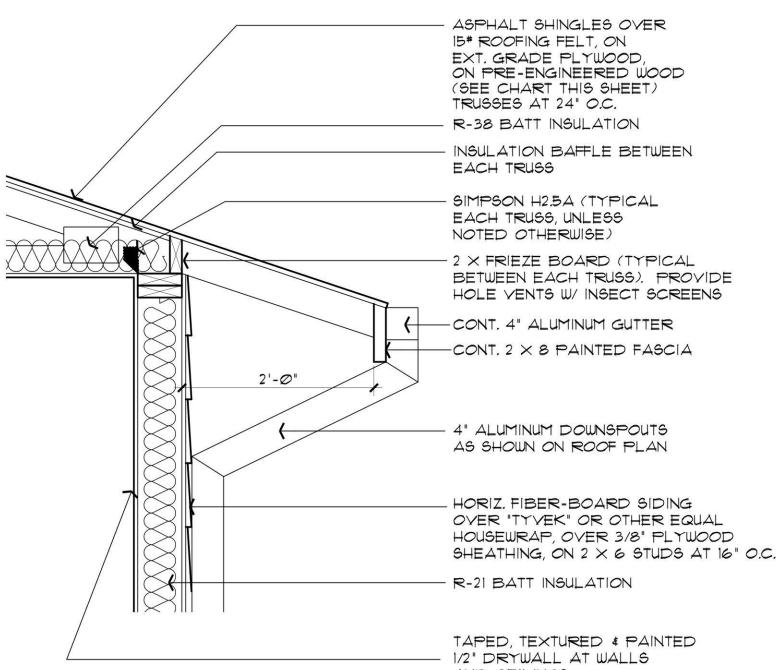

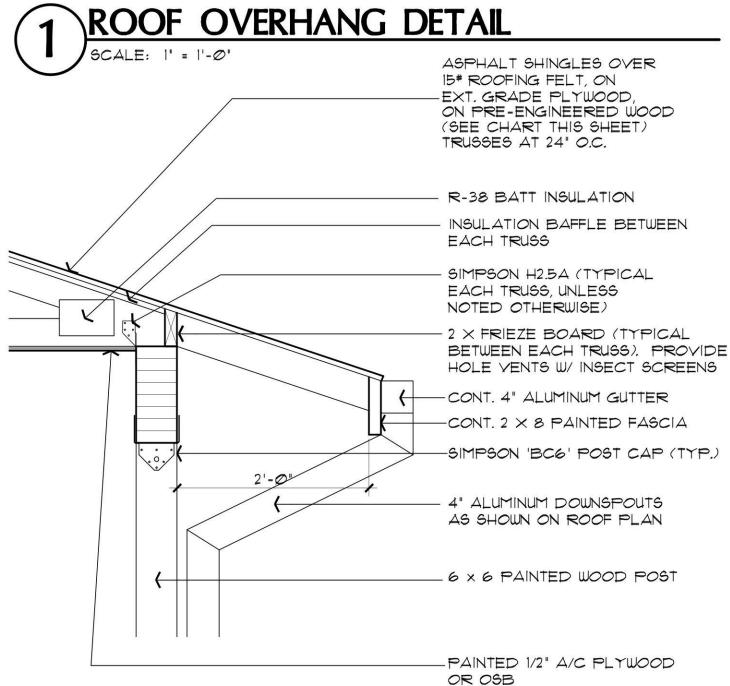

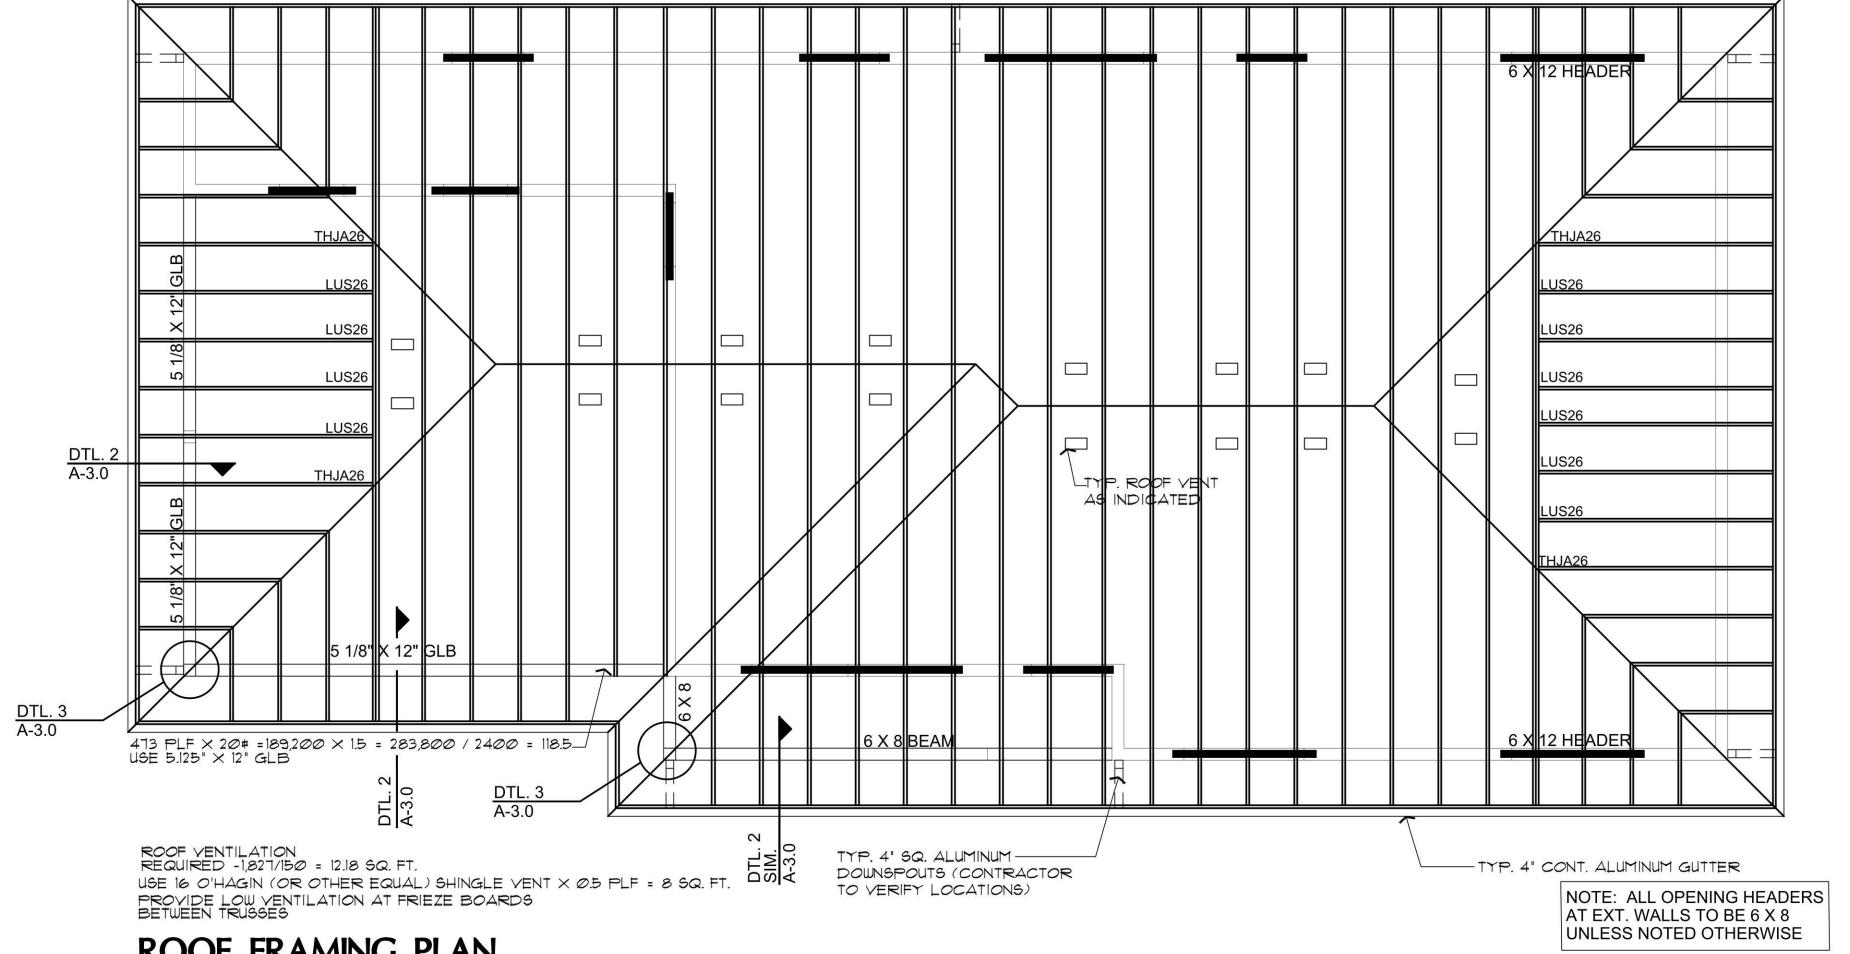

ROOF FRAMING PLAN

TRUSS CALCULATIONS TO BE ON SITE AT TIME OF INSPECTION

INSPECTION AND COMPLIANCE WITH ALL RELEVANT CODES, LAWS AND ORDINANCES

NOTE: PROVIDE PANEL EDGE SUPPORT FOR NARROW-WIDTH ROOF SHEATHING PER APA TECHNICAL REPORT #R275A.


DOUBLE STUDS UNDER | CONNECTIONS TO BE TWO-PLY GIRDER TRUSSES

NOTE: TRUSS-TO-GIRDER SIMPSON HTU26 OR OTHER


Yavapai County Snow Load by Elevation

SCALE: 1/4" = 1'-0"

ELEVATION	SNOW LOAD	FOOTING DEPTH	ROOF SHEATHING
5000 ft. and Below	20 PSF	12" below 4500 ft. 18" above 4500 ft.	1/2"
5001 ft. to 5900 ft.	30 PSF*	18"	1/2"
5901 ft To 6200 ft.	40 PSF*	18"	½" or 5/8" With tile over 60#TL
6201 ft. to 6500 ft.	45 PSF*	18"	5/8"
Over 6501 ft.	50 PSF*	24"	5/8"

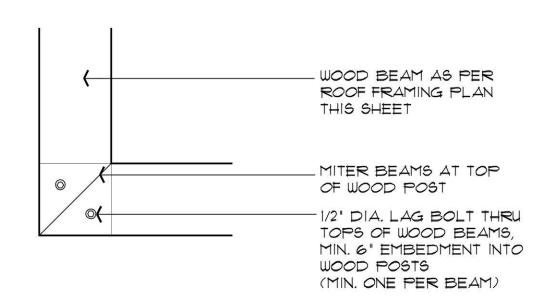

PLAN VIEW - MITERED BEAM AT CORNER POSTS CONNECTION

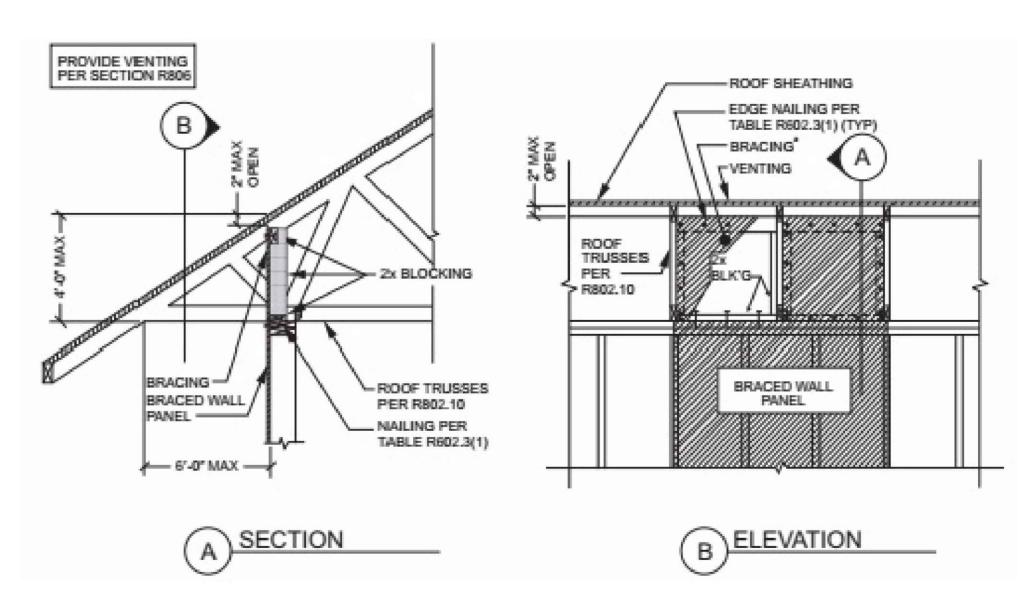

BRACED WALL PANEL CONNECTION OPTION

AT PERPENDICULAR ROOF TRUSSES

2018 IRC FIGURE
2018 IRC FIGURE 2018 IRC FIGURE R602.10.8.2(3)

REVIEWED FOR DESIGN CRITERIA ONLY

Drawn by:

Revisions:

Scale

귑

Marl

Chk'd by : MFR

: AS NOTED

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and is not to be used on any other project. It is to be returned upon request. Scales as stated hereon are valid on the origina drawing only. Contractor shall carefully review all dimensions and conditions shown hereon and at

once report to the Architect any error, inconsistancy or omission he may discover.

32616

ROGERS

84

MARK F

A - 3.0

AND CEILINGS

ROOF OVERHANG AT CARPORT BEAM DETAIL SIM. CONDITION AT FRONT ENTRY

PROPERTY OF YAVAPAI COUNTY. AZ

X

ARIZONA


SBATH


NOF FRAMING ROOF DETA BEDROOM /

VAP.

SHEET NO:

X

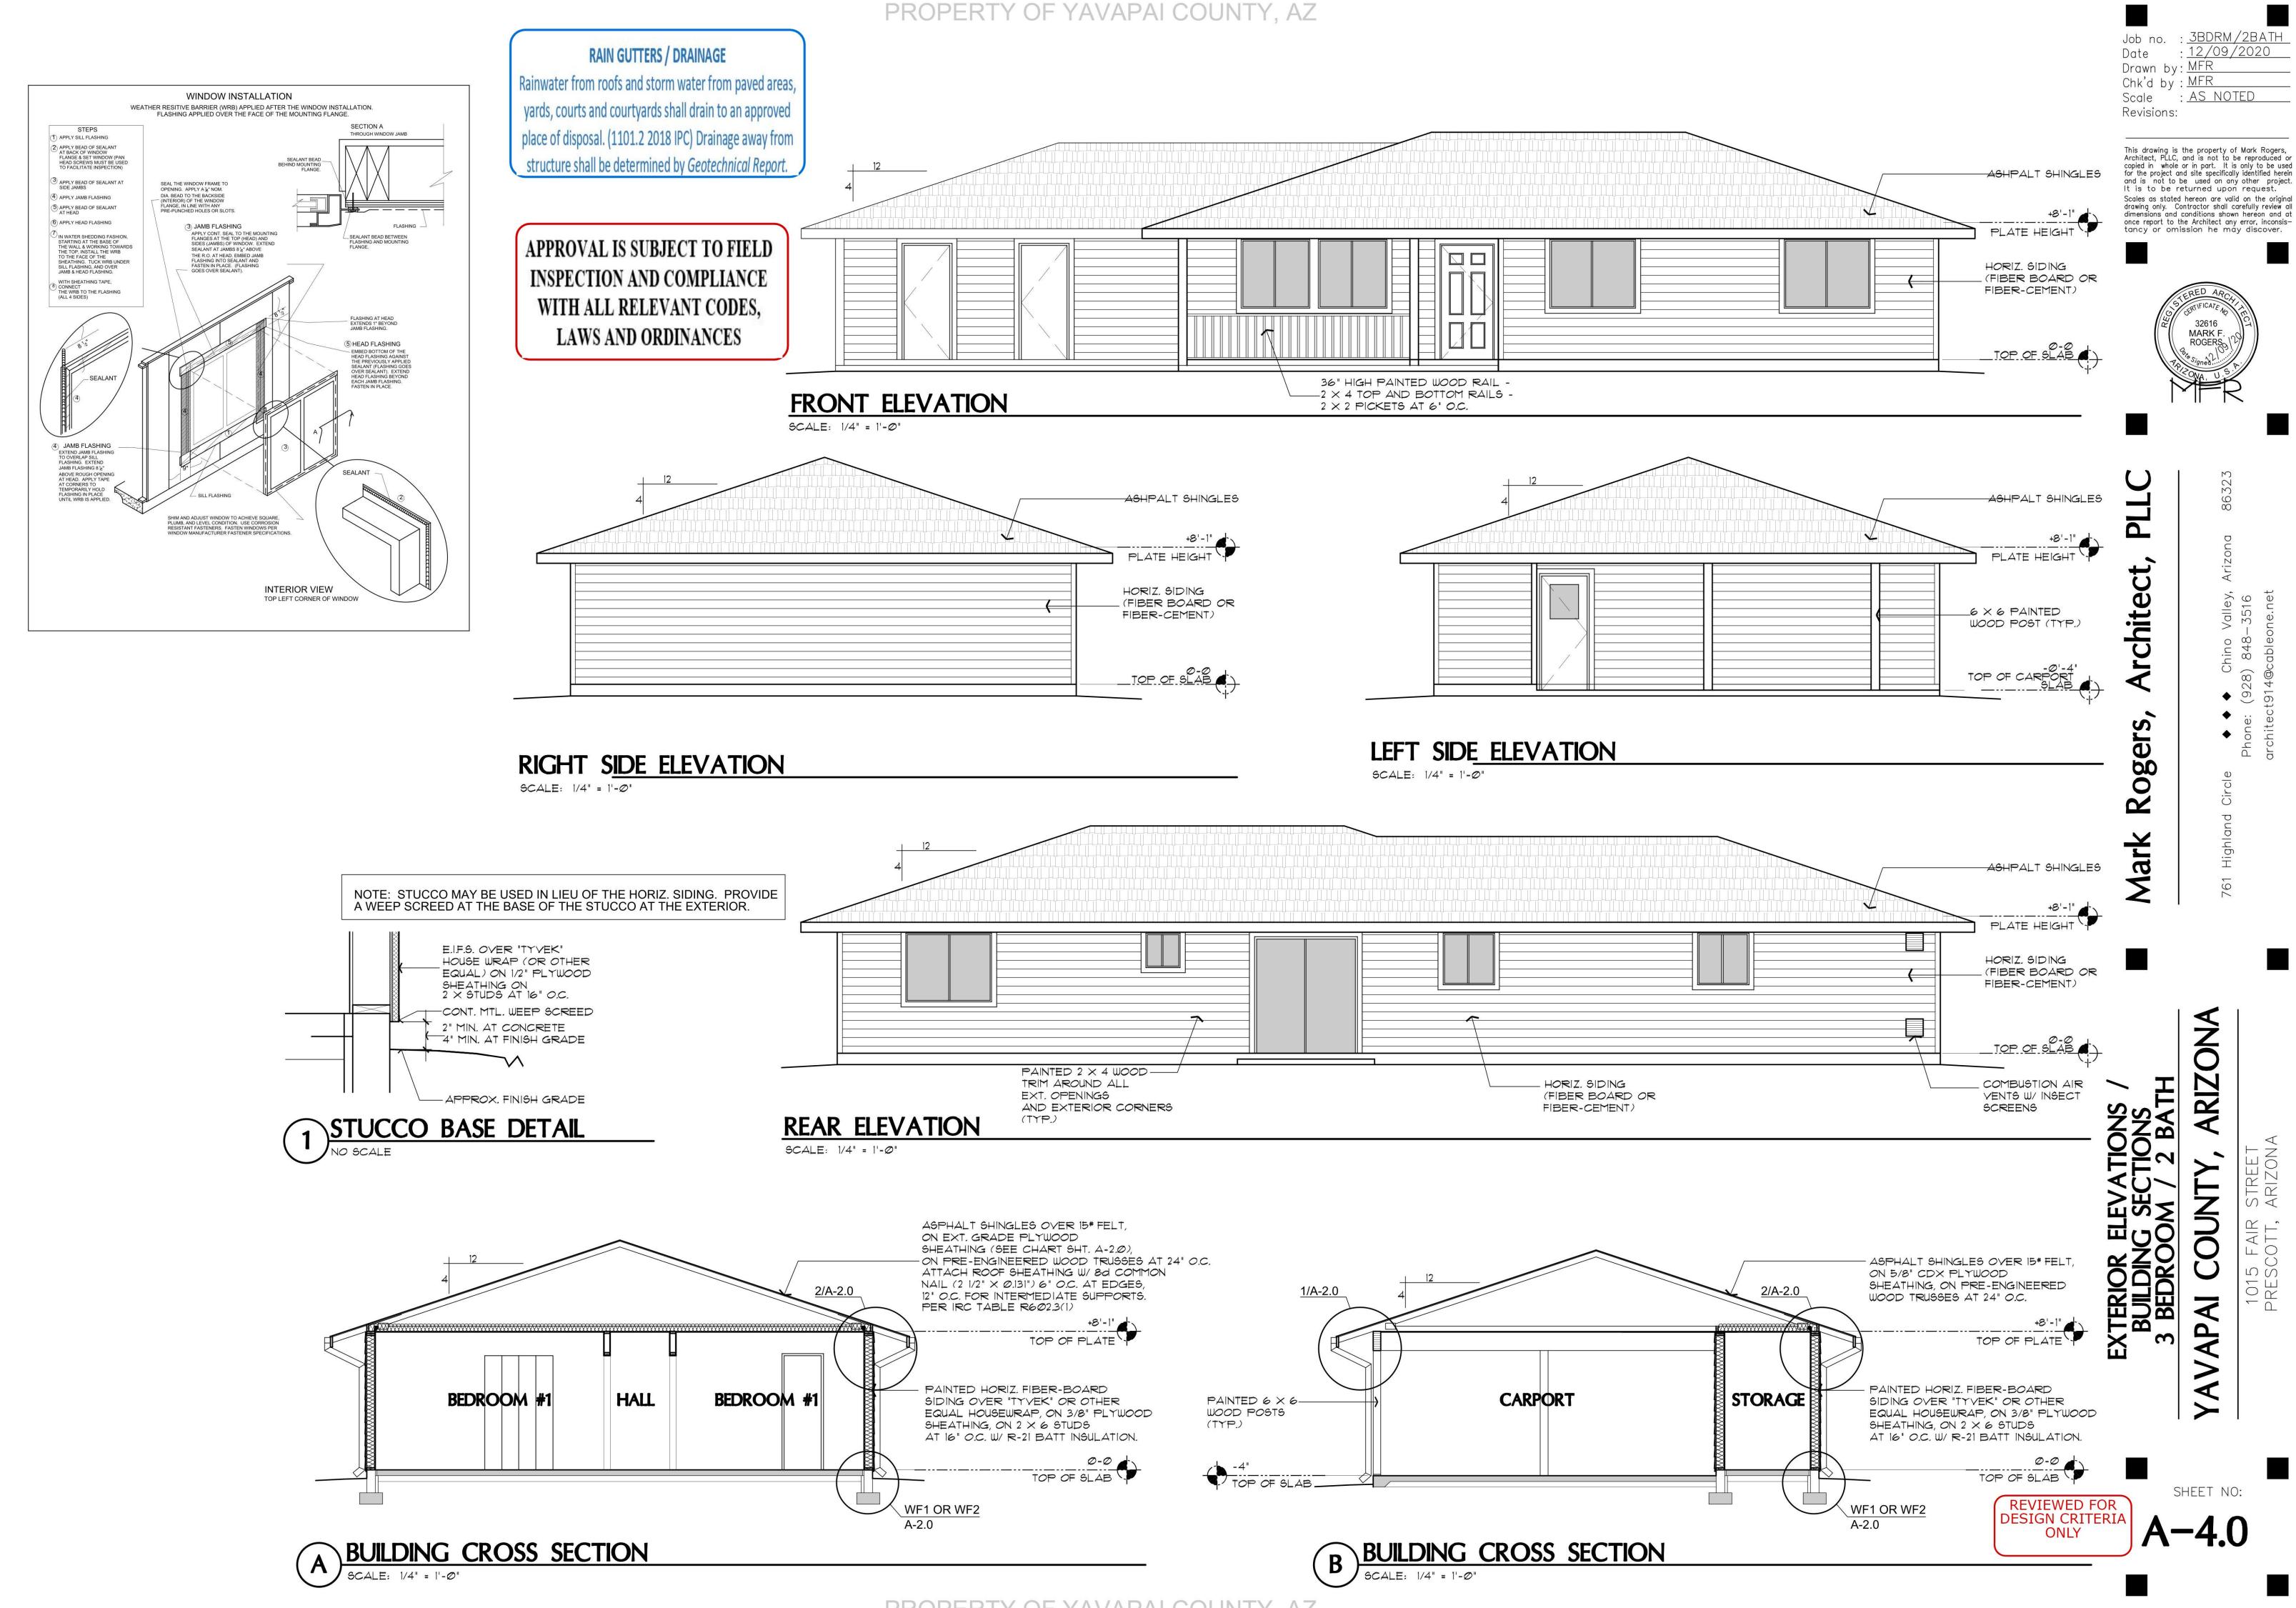

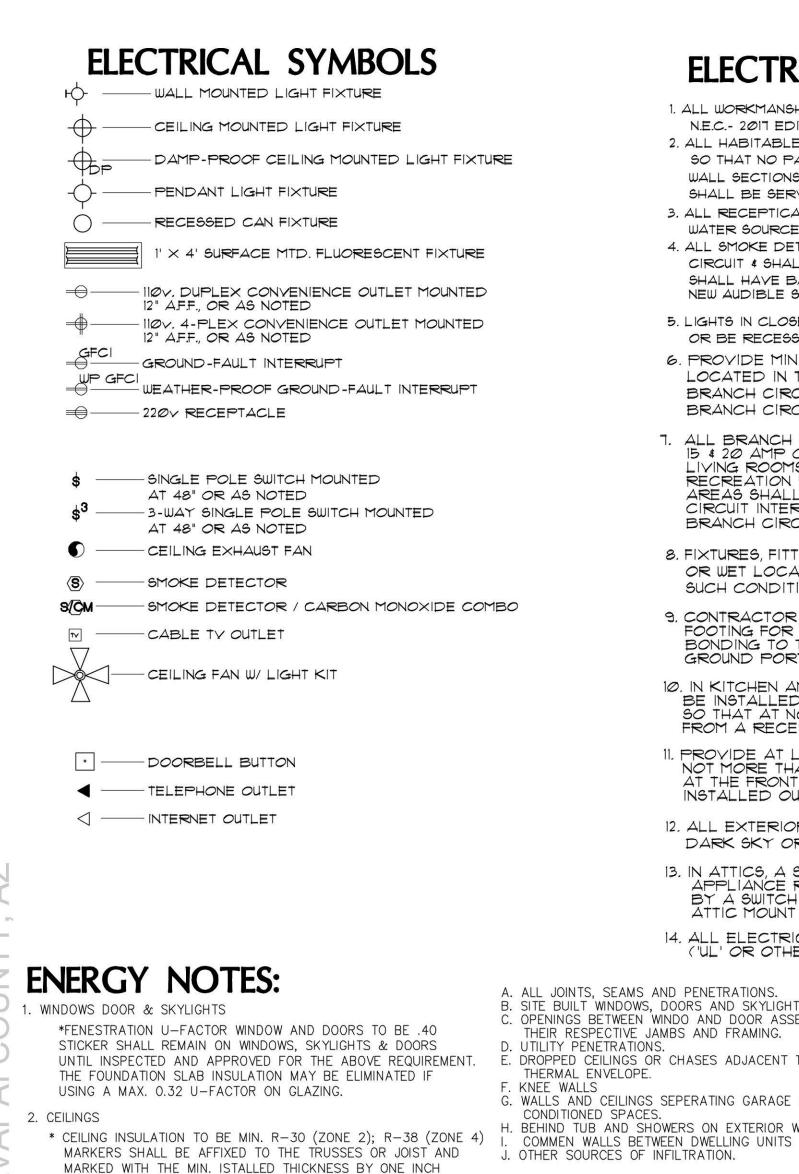

FOR EVERY 300 SQ. FT. OF AREA WITH NUMBERS TO FACE

WOOD FRAMED EXTERIOR WALLS (MIN. R-19 FOR 2 X 6 WALLS)

* WALL INSULATION SHALL BE IN SUBSTANTIAL CONTACT WITH

THE SURFACE BEING INSULATED TO AVOID AIR PATHS THAT

* INSULATION SHALL NOT BE COMPRESSED BY INSET STAPLING

INSULATION AROUND ELECTRCAL OUTLETS AND SWITCHES AND

BY SLICING INSULATION TO FIT BEHIND AND IN FRONT OF

ELECTRICAL WIRING IN THE CAVITY AND PLUMBING PIPING

* BAND JOISTS AND OTHER INTERSTITIAL FLOOR ELEMENTS

THE SEALING METHODS BETWEEN DISSIMILAR MATERAILS

WEATHER STRIPPED OR OTHERWISE SEALED WITH AN AIR

BARRIER MATERIAL, SUITABLE FILM OR SOLID MATERIAL:

CONTRACTION. THE FOLLOWING SHALL BE CAULKED, GASKETED

SHALL ALLOW FOR DIFFERENTAIL EXPANSION AND

* INSULATION SHALL FILL ALL CAVATIES COMPLETLY BY CUTTING

. RECESSED LIGHTING

EXPANSION TANK (PROVIDE SUPPORT)

— S.O.V., (TYP)

- UNION, TYPE

-T&P FULL-SIZE RELIEF LINE

TO EXTERIOR

GALV. DRAIN PAN

ELECTRIC WATER HEATER DETAIL

(24 GA. MIN.)

+ 4" SPACE

ALL AROUND

- CHECK VALVE TYP.

─ HOT WATER RETURN

NOTE: DRAIN PAN, AND T&P

MUST DRAIN BY GRAVITY. WATER

HEATER SHALL BE HIGH ENOUGH

OFF THE FLOOR TO PROVIDE FOR

DISCHARGE PIPING TO EXTERIOR.

AT ROUGH IN OR WALL INSULATION INSPECTIONS.

OF THE BATT INSULATION OR OTHER MEANS

OF THE WALL SHALL BE INSULATED

BYPASS THE INSULATION.

5. BUILDING THERMAL ENVELOPE

DRAIN

EXTERIOR OF

THE ATTIC ACCESS OPENING. MARKERS MUST BE INSTALLED



ELECTRICAL GENERAL NOTES

1. ALL WORKMANSHIP, MATERIALS, AND METHODS SHALL CONFORM TO

3. ALL RECEPTICALS IN BATHROOMS, OUTSIDE & WITHIN 6' OF

2. ALL HABITABLE ROOMS SHALL BE PROVIDED W/ ELECTRICAL OUTLETS

SO THAT NO PART OF THE WALL IS MORE THAN 6' FROM AN OUTLET.


WALL SECTIONS 2' OR LARGER & KITCHEN COUNTERS WIDER THAN 12"

4. ALL SMOKE DETECTORS SHALL BE INTERCONNECTED ON SEPARATE


N.E.C. - 2017 EDITION.

SHALL BE SERVICED BY A RECEPTACLE.

WATER SOURCE SHALL BE G.F.C.I.

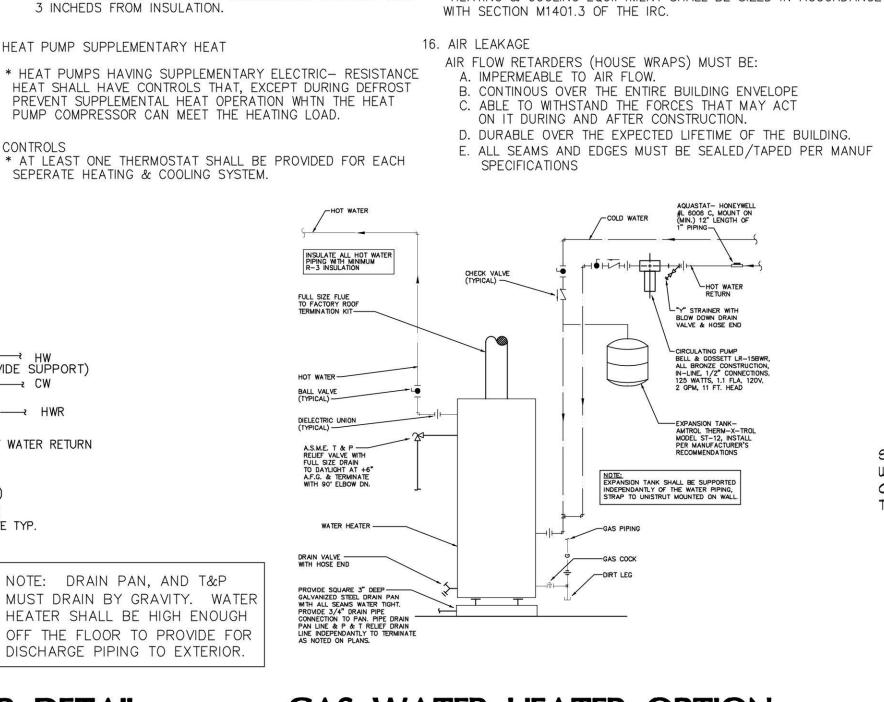

MIN. 1/2" GAS PIPING ISOMETRIC GAS WATER HEATER OPTION NO SCALE

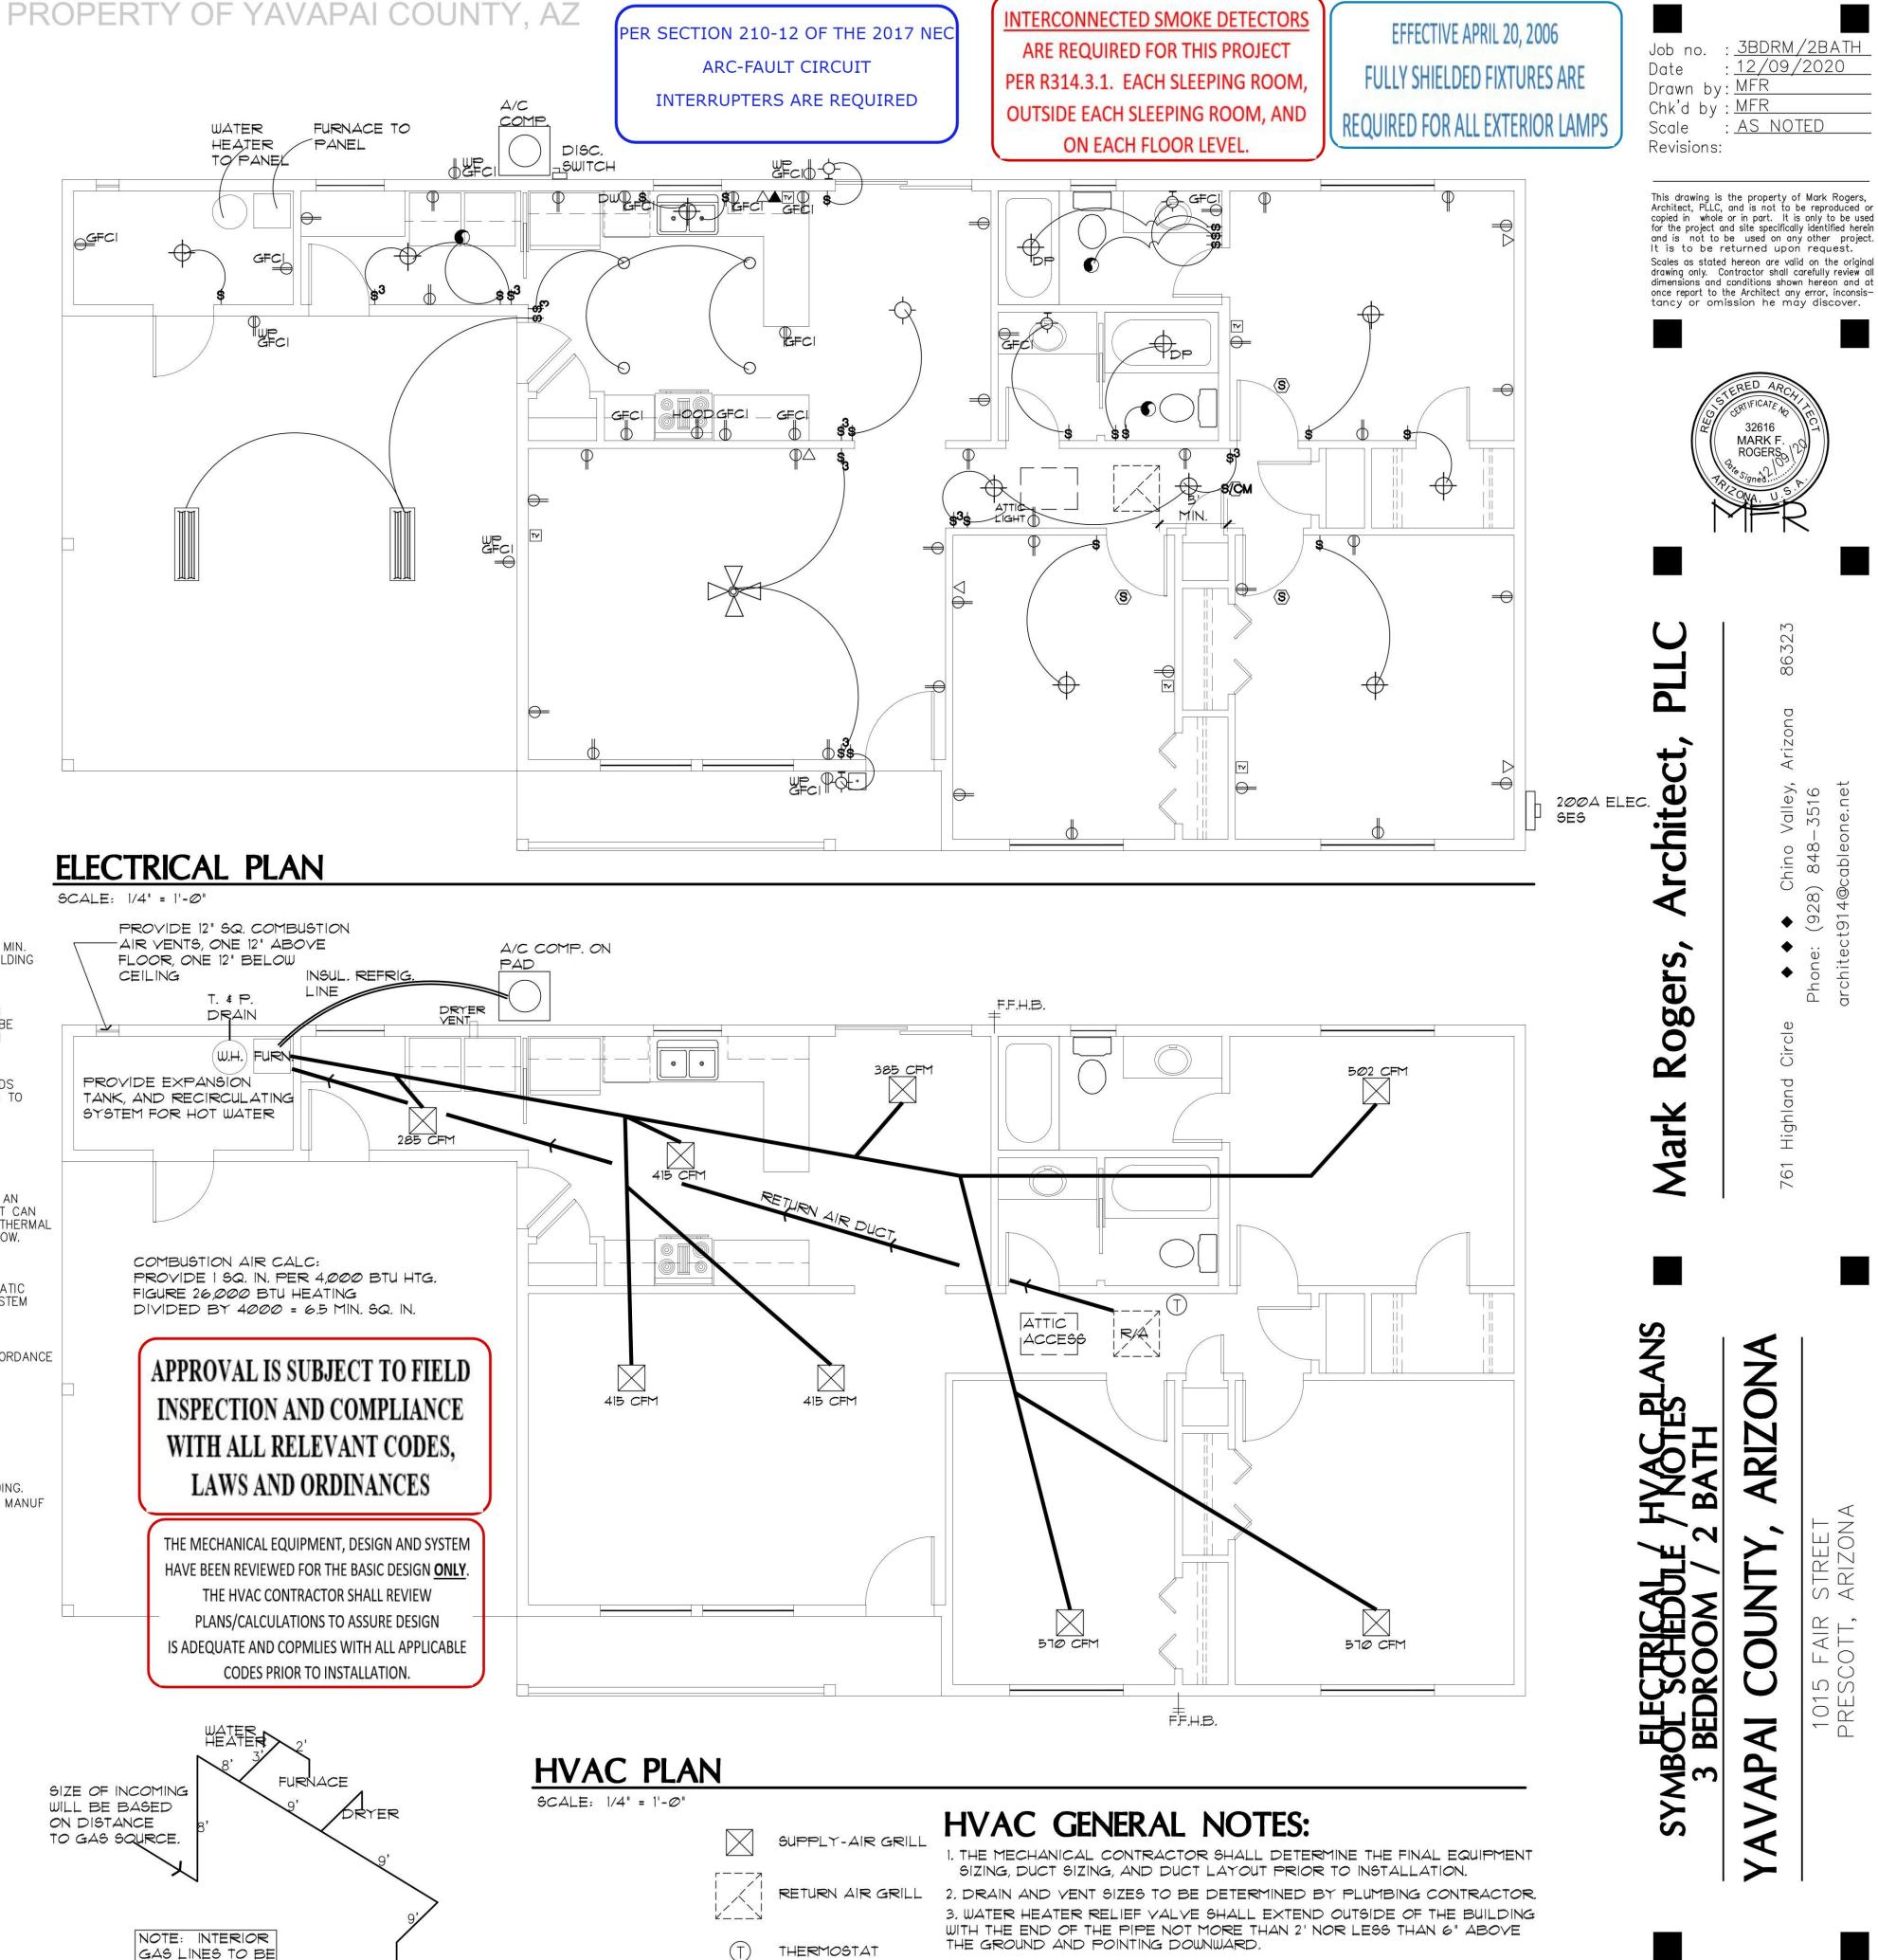

4. PROVIDE A PAN, AND DRAIN FOR THE WATER HEATER

LESS THAN 3' FROM A PROPERTY LINE.

5. THE CLOTHES DRYER EXHAUST DUCT SHALL BE AT LEAST THE DIAMETER

OF THE APPLIANCE OUTLET AS RECOMMENDED BY THE MANUFACTURER AND

SHALL TERMINATE AT THE EXTERIOR OF THE BUILDING. IT SHALL NOT EXCEED 25' IN LENGTH WITH REDUCTIONS FOR BENDS. THE DUCT SHALL TERMINATE NOT 12/09/2020

AS NOTED

MFR

32616

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ARIZ

K

SHEET NO:

REVIEWED FOR

MARK F

RANGE